



FOR RETAINING WALL REINFORCEMENT DETAILS, REFER DRAWING NO. 2427

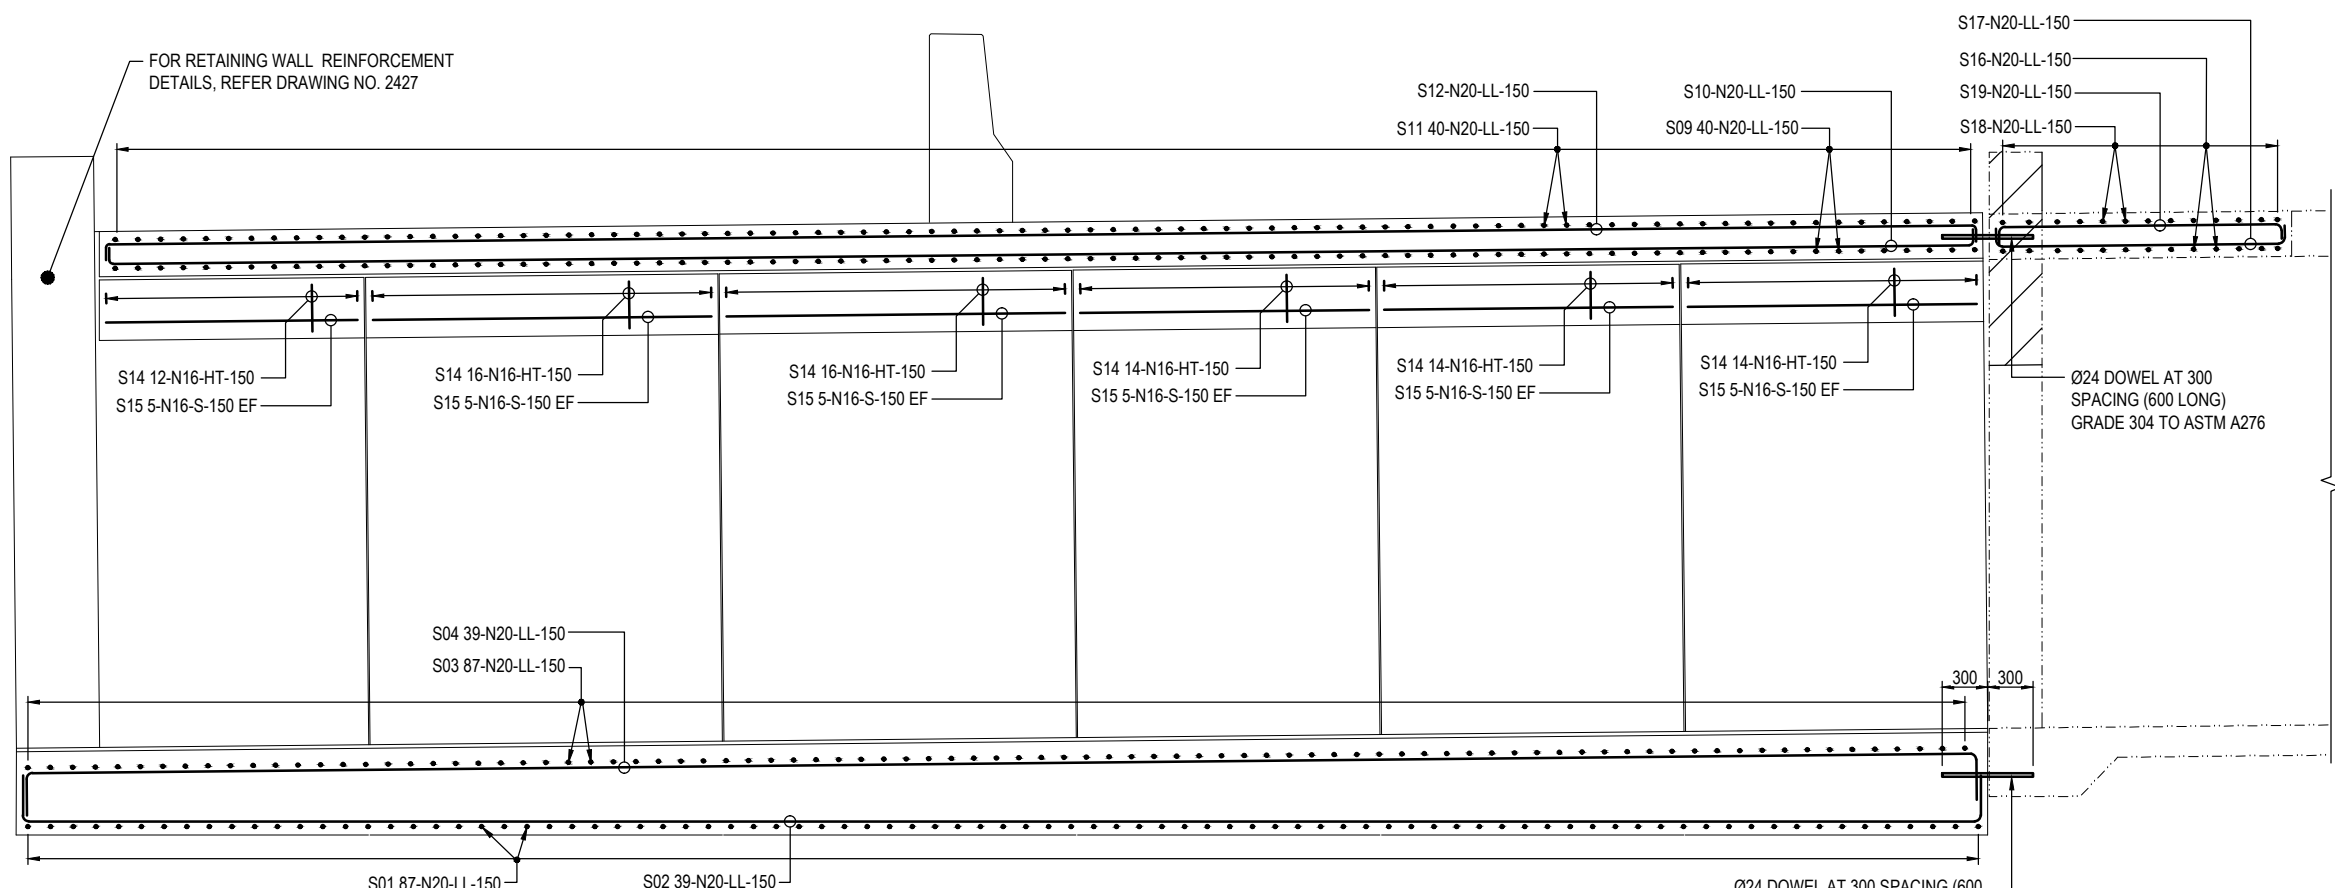

SECTION 3
SCALE 1: 25

Ø24 DOWEL AT 300 SPACING (600 LONG) GRADE 304 TO ASTM A276

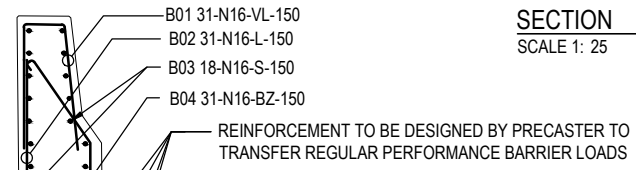

SECTION 2
SCALE 1: 25

Ø24 DOWEL AT 300 SPACING (600 LONG) GRADE 304 TO ASTM A276

150 mm ON ORIGINAL
A1
0 10 20 30 40 50 60 70 80 90 100 110 120 130 140 150

DRAWING FILE LOCATION / NAME V:\Vault\Projects\3002750\CAD\DWG\17_SC_Struct\RETAINING_WALLS\3002750-RW-2426.dwg		PLOT DATE 29 Feb 2024		TIME 19:46:25	
EXTERNAL REFERENCE FILES	REV	DATE	AMENDMENT / REVISION DESCRIPTION	WVR No.	APPROVAL
	A	29.02.2024	DRAFT DOCUMENT READINESS (DR) SUBMISSION	0036	T.VN
	DRAFTER	NAME			
	DRAFTING CHECK	M.SURESH			
	DESIGNER	V. RAMAMURTHY			
	DESIGN CHECK	S.MONTGOMERY			
	PROJECT MANAGER	R. HUNTER			
PROJECT DIRECTOR	K. DECANHA				
SCALE AT A1 SIZE DRAWING			DESIGNER		
SCALE 1:25			 Member of the Surbana Jurong Group ABN 47 065 475 149 LEVEL 9, 12 MOORE STREET CANBERRA ACT 2601 AUSTRALIA SMEC PROJECT No 3002750		
SCALE AT A1 SIZE DRAWING			CLIENT		
SCALE 1:25			 Transport Canberra & City Services		
PROJECT TITLE WILLIAM HOVELL DRIVE DUPLICATION					
UNDERPASS (1155) AT CHAINAGE 4588 REINFORCEMENT DETAILS - SHEET 2					
SCALE AS SHOWN	PHASE DETAIL DESIGN	PROJECT / DRAWING No. 3002750-RW-2426	REVISION A	DR	